### Cartificate number: 17828/05

Water Commitments	Show on DA plans	Show on CC/CDC plans & specs	Certifier check
Fixtures	DA plans	plans & specs	CHECK
The applicant must install showerheads with a minimum rating of 4 star (> 6 but <= 7.5 L/min plus spray force and/or coverage tests) in			
all showers in the development.  The applicant must install a toilet flushing system with a minimum rating of 4 star in each toilet in the development.		•	•
The applicant must install taps with a minimum rating of 4 star in the kitchen in the development.		~	~
AND RESERVOIR OF THE PROPERTY		~	
The applicant must install basin taps with a minimum rating of 4 star in each bathroom in the development.		~	
Alternative water			
Rainwater tank			
The applicant must install a rainwater tank of at least 3000 litres on the site. This rainwater tank must meet, and be installed in accordance with, the requirements of all applicable regulatory authorities.	~	~	~
The applicant must configure the rainwater tank to collect rain runoff from at least 61.5 square metres of the roof area of the development (excluding the area of the roof which drains to any stormwater tank or private dam).		~	~
The applicant must connect the rainwater tank to:			
all tollets in the development		~	~
the cold water tap that supplies each clothes washer in the development		~	~
<ul> <li>at least one outdoor tap in the development (Note: NSW Health does not recommend that rainwater be used for human consumption in areas with potable water supply.)</li> </ul>			
Thermal Performance and Materials commitments	Show on	Show on CC/CDC	Certifier
Thermal Performance and Materials commitments	DA plans	plans & specs	check
Simulation Method			
Assessor details and thermal loads  The applicant must attach the certificate referred to under "Assessor Details" on the front page of this BASIX certificate (the "Assessor	Г	T	
The applicant must assist in the central element to funder "Assession Deats and in the front page of this Assist central element application and construction certificate application for the proposed development or, if the applicant page applying for a complying development certificate for the proposed development, to that application. The applicant must also attach the Assessor Certificate to the application for an occupation certificate for the proposed development.			
The Assessor Certificate must have been issued by an Accredited Assessor in accordance with the Thermal Comfort Protocol.			
The details of the proposed development on the Assessor Certificate must be consistent with the details shown in this BASIX certificate, including the Cooling and Heating loads shown on the front page of this certificate and the "Construction" and "Glazing" tables below.			
The applicant must show on the plans accompanying the development application for the proposed development, all matters which the Assessor Certificate requires to be shown on those plans. Those plans must bear a stamp of endorsement from the Accredited Assessor to certify that this is the case. The applicant must show on the plans accompanying the application for a construction certificate (or complying development certificate, if applicable), all thermal performance specifications set out in the Assessor Certificate, and all aspects of the proposed development which were used to calculate those specifications.	~	~	~
The applicant must construct the development in accordance with all thermal performance specifications set out in the Assessor Certificate, and in accordance with those specification or application or a complying development certificate which were used to calculate those specifications.		~	~
The applicant must show on the plans accompanying the development application for the proposed development, the locations of ceiling fans set out in the Assessor Certificate. The applicant must show on the plans accompanying the application for certificate (or complying development certificate, if applicable), the locations of ceiling fans set out in the Assessor Certificate.	~	~	~
Thermal Performance and Materials commitments	Show on DA plans	Show on CC/CDC plans & specs	Certifier check
Construction			
The applicant must construct the floors, walls, roofs, ceilings and glazing of the dwelling in accordance with the specifications listed in the tables below.	~	~	~
The applicant must show through receipts that the materials purchased for construction are consistent with the specifications listed in the tables below			~
Thermal Berformance and Materials commitments	Show on	Show on CC/CDC	Certifier
Thermal Performance and Materials commitments	DA plans	plans & specs	check
Glazing  The applicant must install windows, glazed doors and skylights as described in the table below, in accordance with the specifications			1
listed in the table.	~	~	~
Energy Commitments	Show on DA plans	Show on CC/CDC plans & specs	Certifier
Hot water			
The applicant must install the following hot water system in the development, or a system with a higher energy rating: gas			
instantaneous with a performance of 6 stars.	•	<u> </u>	•
Cooling system  The applicant must install the following cooling system, or a system with a higher energy rating, in at least 1 living area: 1-phase		1	
airconditioning - ducted; Energy rating: 3 star (average zone)		~	~
The applicant must install the following cooling system, or a system with a higher energy rating, in at least 1 bedroom: 1-phase airconditioning - ducted; Energy rating: 3 star (average zone)		~	~
Heating system			
The applicant must install the following heating system, or a system with a higher energy rating, in at least 1 living area: 1-phase airconditioning - ducted; Energy rating: 3.5 star (average zone)		~	~
The applicant must install the following heating system, or a system with a higher energy rating, in at least 1 bedroom: 1-phase airconditioning - ducted; Energy rating: 3.5 star (average zone)			
arconditioning - ducted; Energy rating: 3.5 star (average zone)  Ventilation		•	
The applicant must install the following exhaust systems in the development:		¥0	
At least 1 Bathroom: individual fan, ducted to façade or roof; Operation control: please select			J
Kitchen: individual fan, ducted to façade or roof; Operation control: manual switch on/off			
		~	~
Laundry: natural ventilation only, or no laundry; Operation control: n/a		~	~
Laundry: natural ventilation only, or no laundry; Operation control: n/a			
Artificial lighting The applicant must ensure that a minimum of 80% of light fixtures are fitted with fluorescent, compact fluorescent, or light-emitting-			2.00
Artificial lighting  The applicant must ensure that a minimum of 80% of light fixtures are fitted with fluorescent, compact fluorescent, or light-emitting-liode (LED) lamps.		~	~
Artificial lighting The applicant must ensure that a minimum of 80% of light fixtures are fitted with fluorescent, compact fluorescent, or light-emitting- liode (LED) lamps.  Natural lighting		~	~
Artificial lighting  The applicant must ensure that a minimum of 80% of light fixtures are fitted with fluorescent, compact fluorescent, or light-emitting-liode (LED) lamps.	~	~	~



613.10 m <sup>2</sup>
154.60 m <sup>2</sup>
187.35 m²
37.25 m <sup>2</sup>
7.68 m <sup>2</sup>
N/A m²
43.78 m²
m²
430.66 m²

2.5 STREETSCAPE ELEVATION

							2.4	NEIGHBOUR NOTIFICATION PLAN
							2.3	SHADOW DIAGRAM
							2.2	SITE ANALYSIS PLAN
							2.1	CONSTRUCTION MANAGEMENT
	I	T	T					
QUOTE	DATE	QUOTE NUMBER	REV				14	ROOF PLAN
KITCHEN			-					
ZURCORP ELECTRICAL			-				12	SLAB PLAN
TILES			-				11	WET AREA DETAILS
CARPET			-				10	WET AREA DETAILS
ZURCORP SECURITY			-				9	ELECTRICAL LAYOUT
EHI			-				8	ELECTRICAL LAYOUT
AIR CONDITIONING			-	G	21.03.25 HYDRAULICS CO-ORDINATED	M.H.	7	SECTION
STAIRS			-	F	05.03.25 EXTERNAL COLOURS	NI	6	ELEVATIONS
LANDSCAPE				Е	20.02.25 AMENDMENT	DR	5	ELEVATIONS
HYDRAULICS				D	14.02.25 DA DRAWINGS	MTK/MJ	4	FIRST FLOOR PLAN
ENGINEER				С	03.02.25 CV-1	AL	3	GROUND FLOOR PLAN
PEG OUT				В	13.01.25 CONTRACT DRAWINGS	MTK	2	SITE PLAN
				Α	05.12.24 TENDER SITING	NI	1	COVER SHEET
SIGNATURE: DATE:				REV	DATE AMENDMENTS	BY	SHEET	DESCRIPTION

The applicant must install a gas cooktop & electric oven in the kitchen of the dwelling.

ClarendonHomes

BL No. 2298C
ABN 18 003 892 706

Clarendon Homes (NSW) P/L
21 Solent Circuit, Baulkham Hills NSW 2153
T: (02) 8851 5300

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AND CORPORATION HOMES (NSW) P/L
CLARENDON HOMES (NSW) P/L
AND CORPORATION HOMES (NSW) P/L
AND CORPORATION HOMES (NSW) P/L
AND IMPRESENTED TO SCALING.

PRODUCT: STAMFORD 41 Bayview L/H Garage

Revision: A

Master Issued: 22.08.24


CLIENT: Mr. KORKES Mrs. KORKES SITE ADDRESS: Lot 14, No.150 Tompson Road PANANIA 2213


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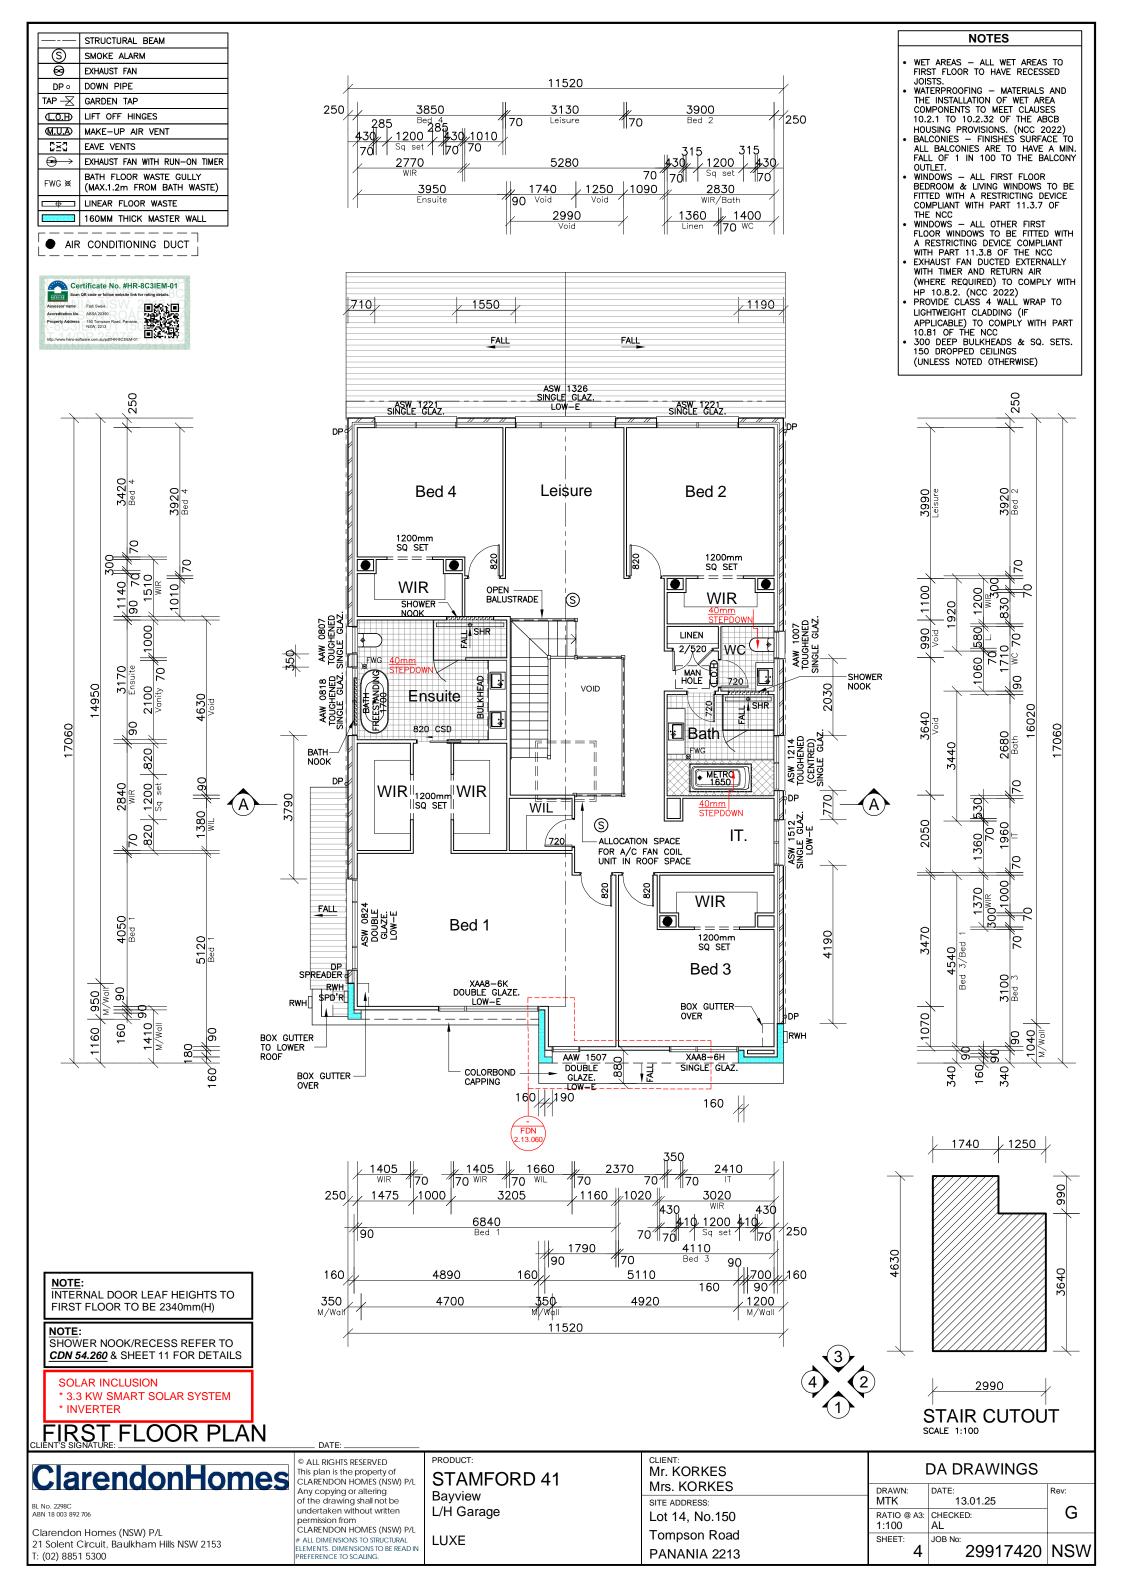
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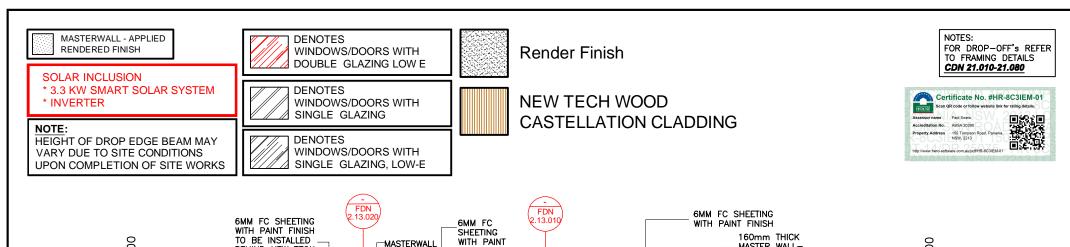
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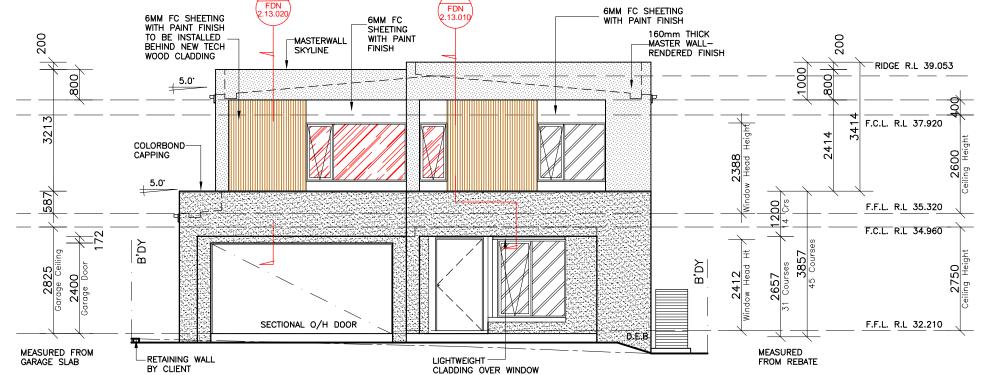
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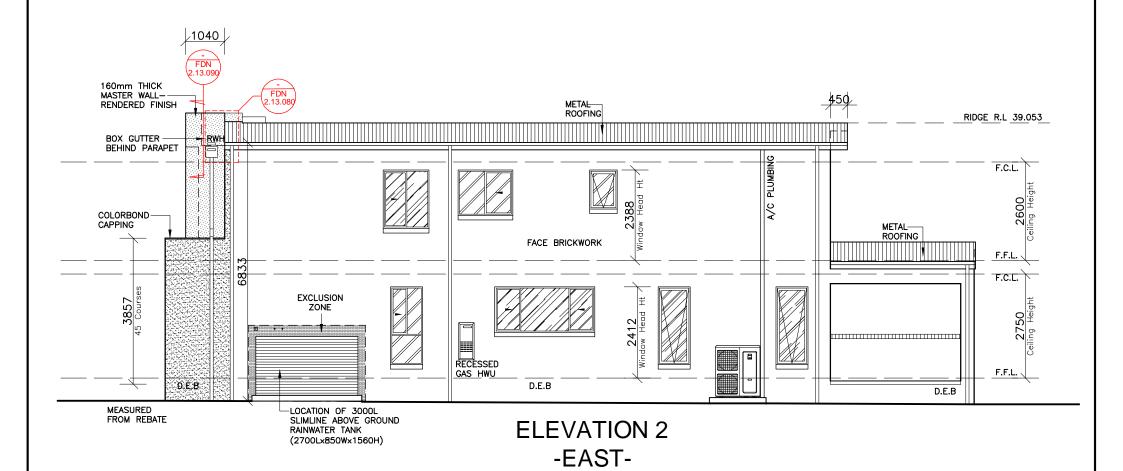








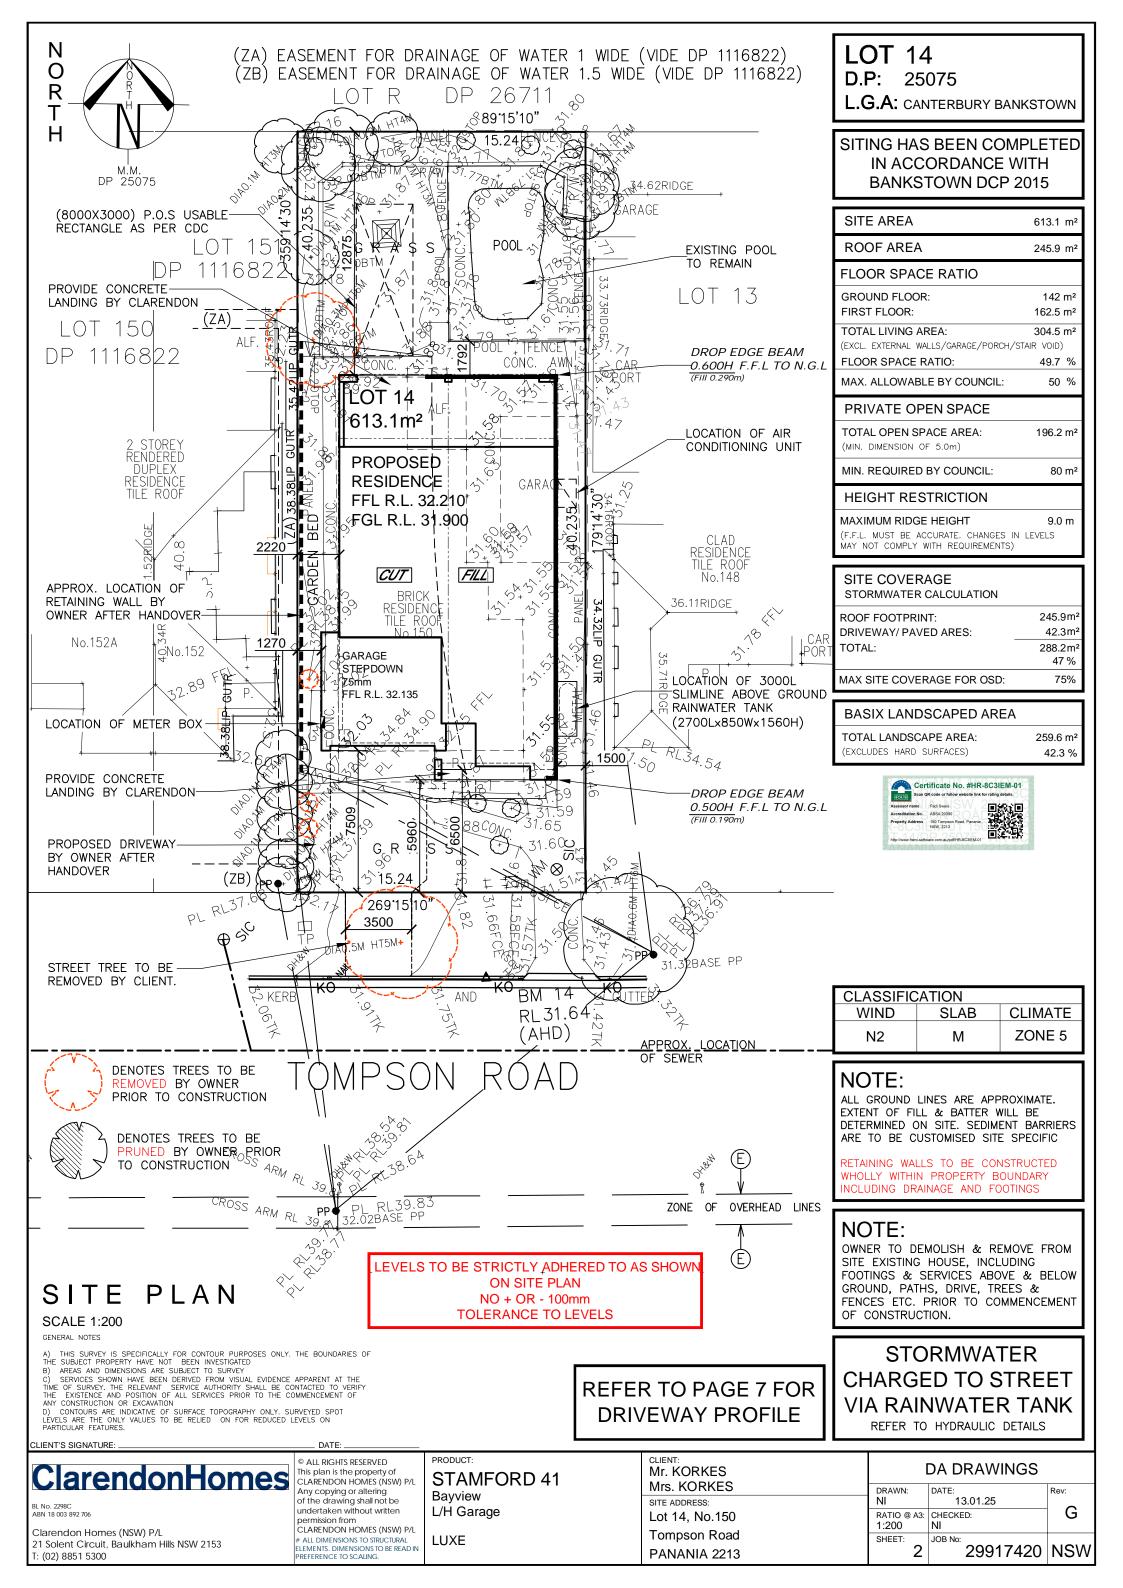

ELEVATION 1
-SOUTH-

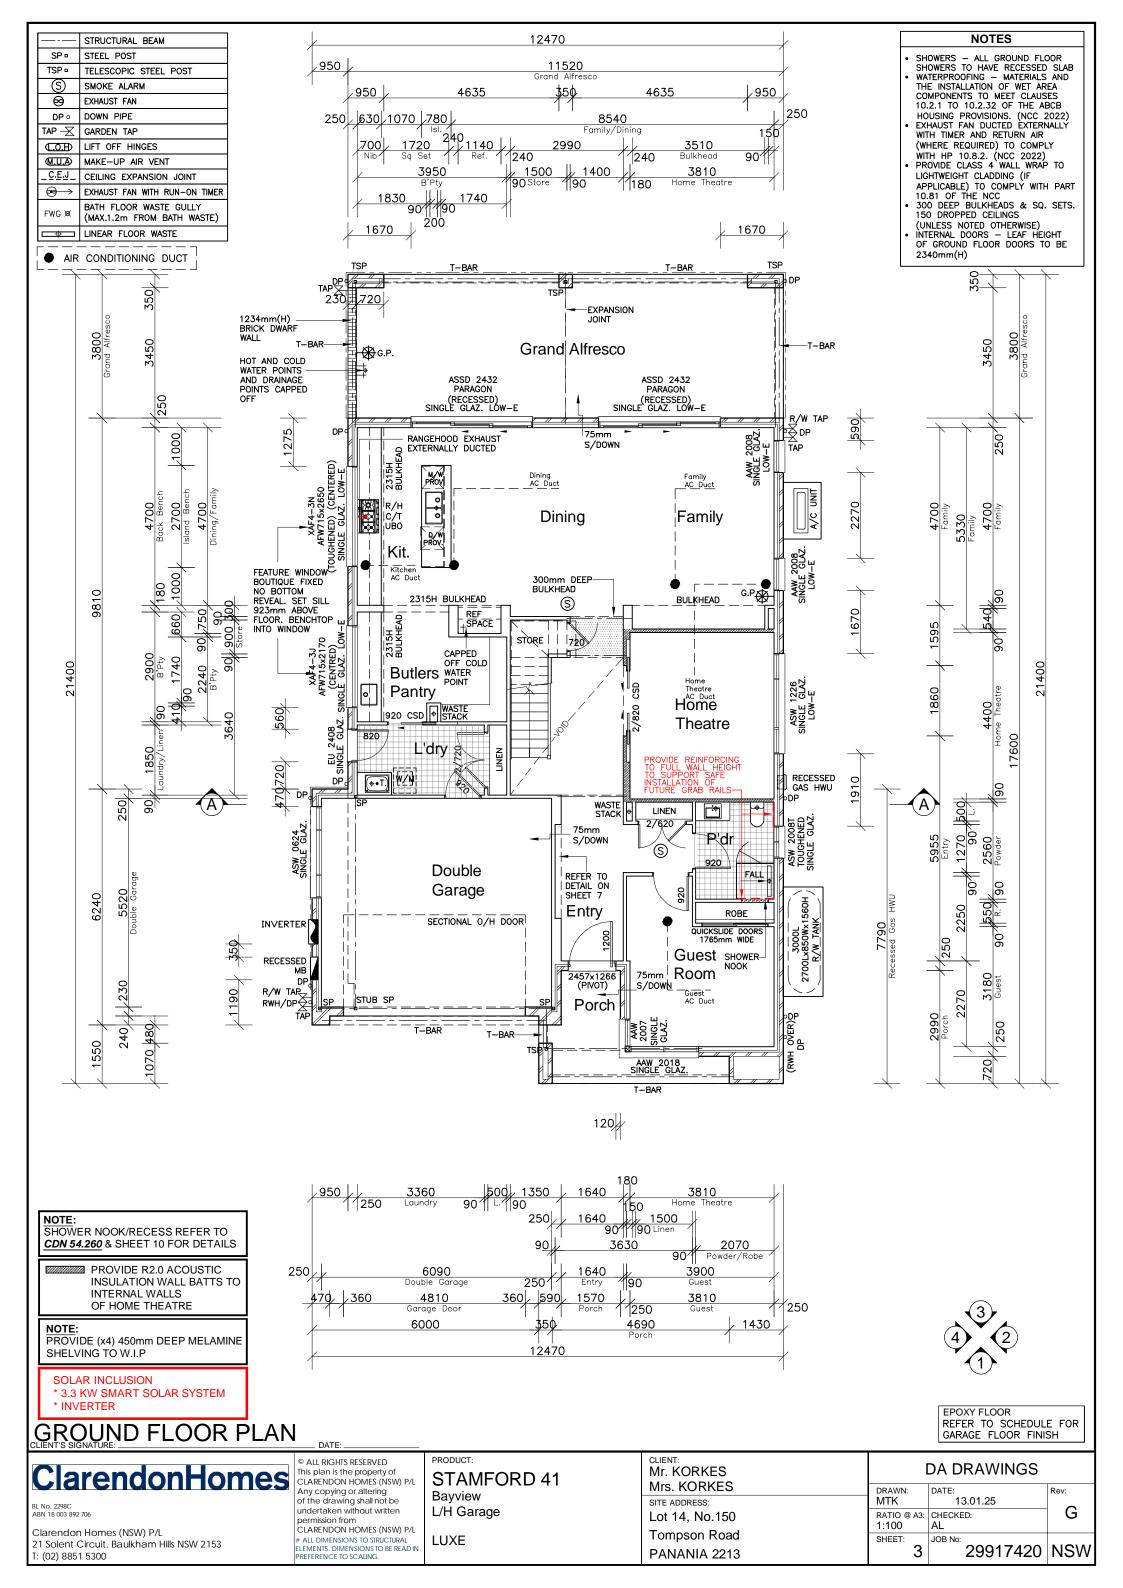

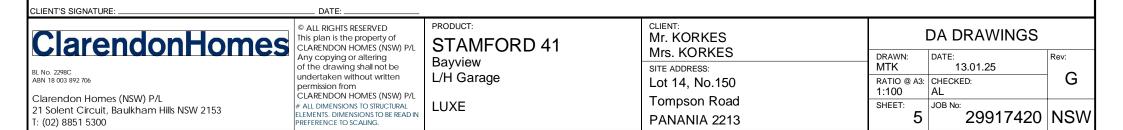


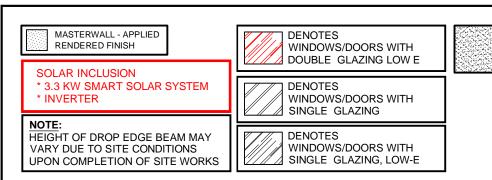


Render Finish

NOTES: FOR DROP-OFF'S REFER TO FRAMING DETAILS CDN 21.010-21.080



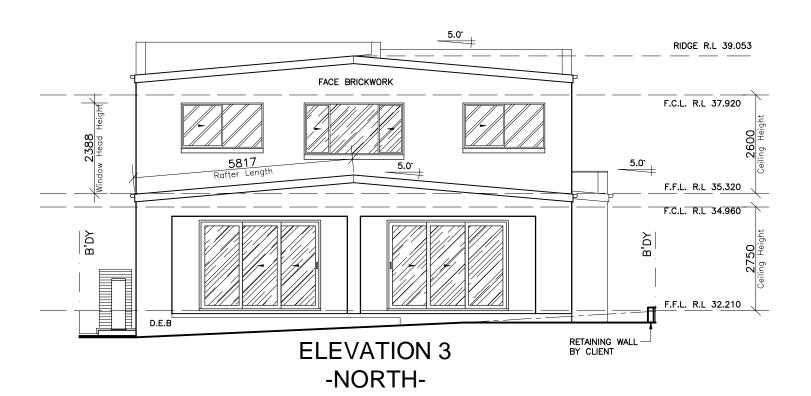

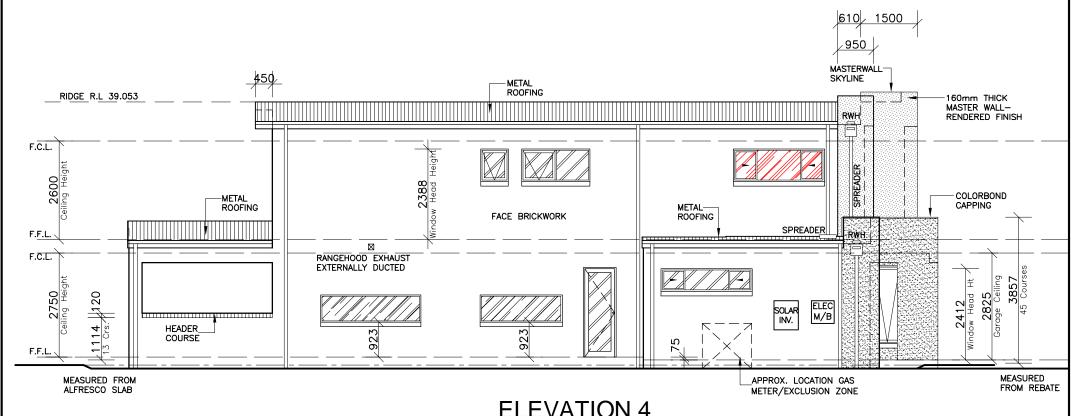

ELEVATION 4 -WEST-

ClarendonHomes

BL No. 2298C ABN 18 003 892 706

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# ALL DIMENSIONS TO STRUCTURAL
ELEMENTS. DIMENSIONS TO BE READ IN
PREFERENCE TO SCALING.

STAMFORD 41
Bayview
L/H Garage

LUXE

CLIENT: DA DRAWINGS Mr. KORKES Mrs. KORKES DRAWN: DATE: Rev: MTK 13.01.25 SITE ADDRESS: G RATIO @ A3: CHECKED: Lot 14, No.150 1:100 AL Tompson Road SHEET: JOB No: 29917420 NSW PANANIA 2213

NOTE: INTERNAL DOOR LEAF HEIGHTS TO GROUND & FIRST FLOOR TO BE

NOTE: PROVIDE R2.2 TO INTERNAL WALLS BETWEEN HOUSE AND GARAGE (ONLY)

NOTE:

2340mm(H)

PROVIDE R6.0 WITH R3.5 TO ROOF PERIMETER WHERE R6.0 WILL NOT FIT (EXCLUDING GARAGE)

NOTE: PROVIDE R5.0 TO FLOOR JOISTS BETWEEN GROUND & FIRST FLOOR

PROVIDE R6.0 TO OVERHANGING


FLOOR IN BED 1 AND BED 3 PROVIDE R5.0 INSULATION BATTS TO CEILING JOISTS BETWEEN GROUND FLOOR & FIRST FLOOF


PROVIDE R5.0 INSULATION BATTS TO CEILING JOISTS BETWEEN PORCH & FIRST FLOOR R3.5 INSULATION INSTALLED AS PART OF ONSTRUCTION METHOD)




NOTE:
PROVIDE ACOUSTIC INSULATION BATTS BETWEEN GROUND & FIRST

PROVIDE CLASS 4 WALL WRAP TO LIGHTWEIGHT CLADDING

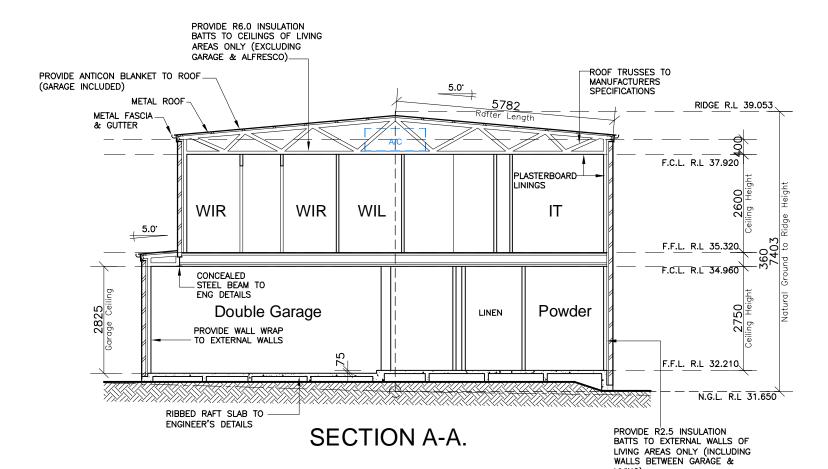


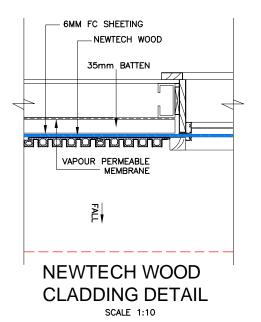

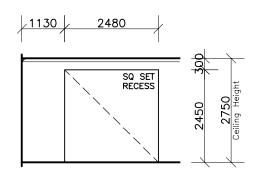

**ENTRY HALLWAY** DETAIL

VIEWED FROM ENTRY

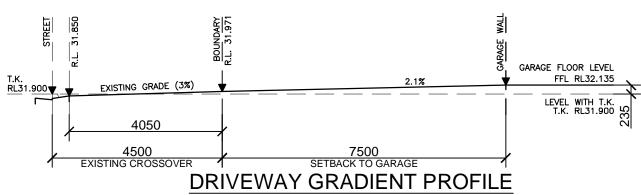

SCALE-1:100

CLIENT'S SIGNATURE: ClarendonHomes


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PRODUCT: STAMFORD 41 Bayview L/H Garage

**LUXE** 

CLIENT: DA DRAWINGS Mr. KORKES Mrs. KORKES DATE: DRAWN: Rev: 13.01.25 SITE ADDRESS: MTK G Lot 14, No.150 RATIO @ A3: CHECKED: 1:100 | AL Tompson Road SHEET: JOB No: 29917420 NSW PANANIA 2213



# ROOF PLAN SCALE: 1:100
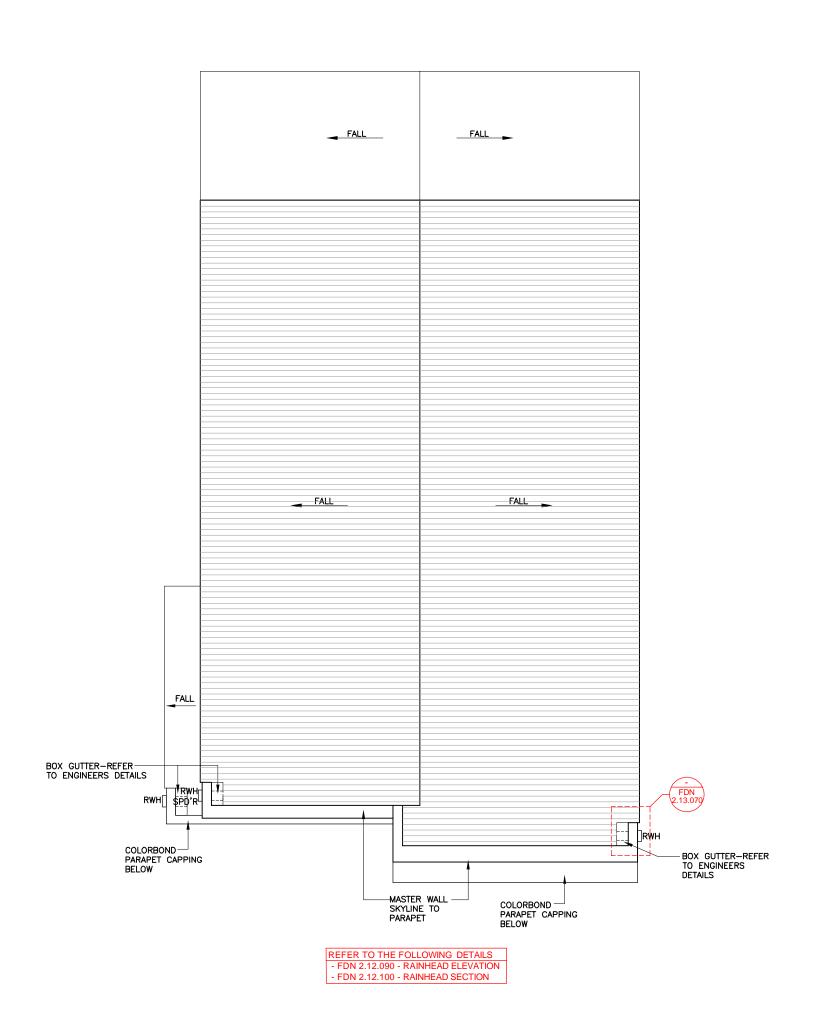
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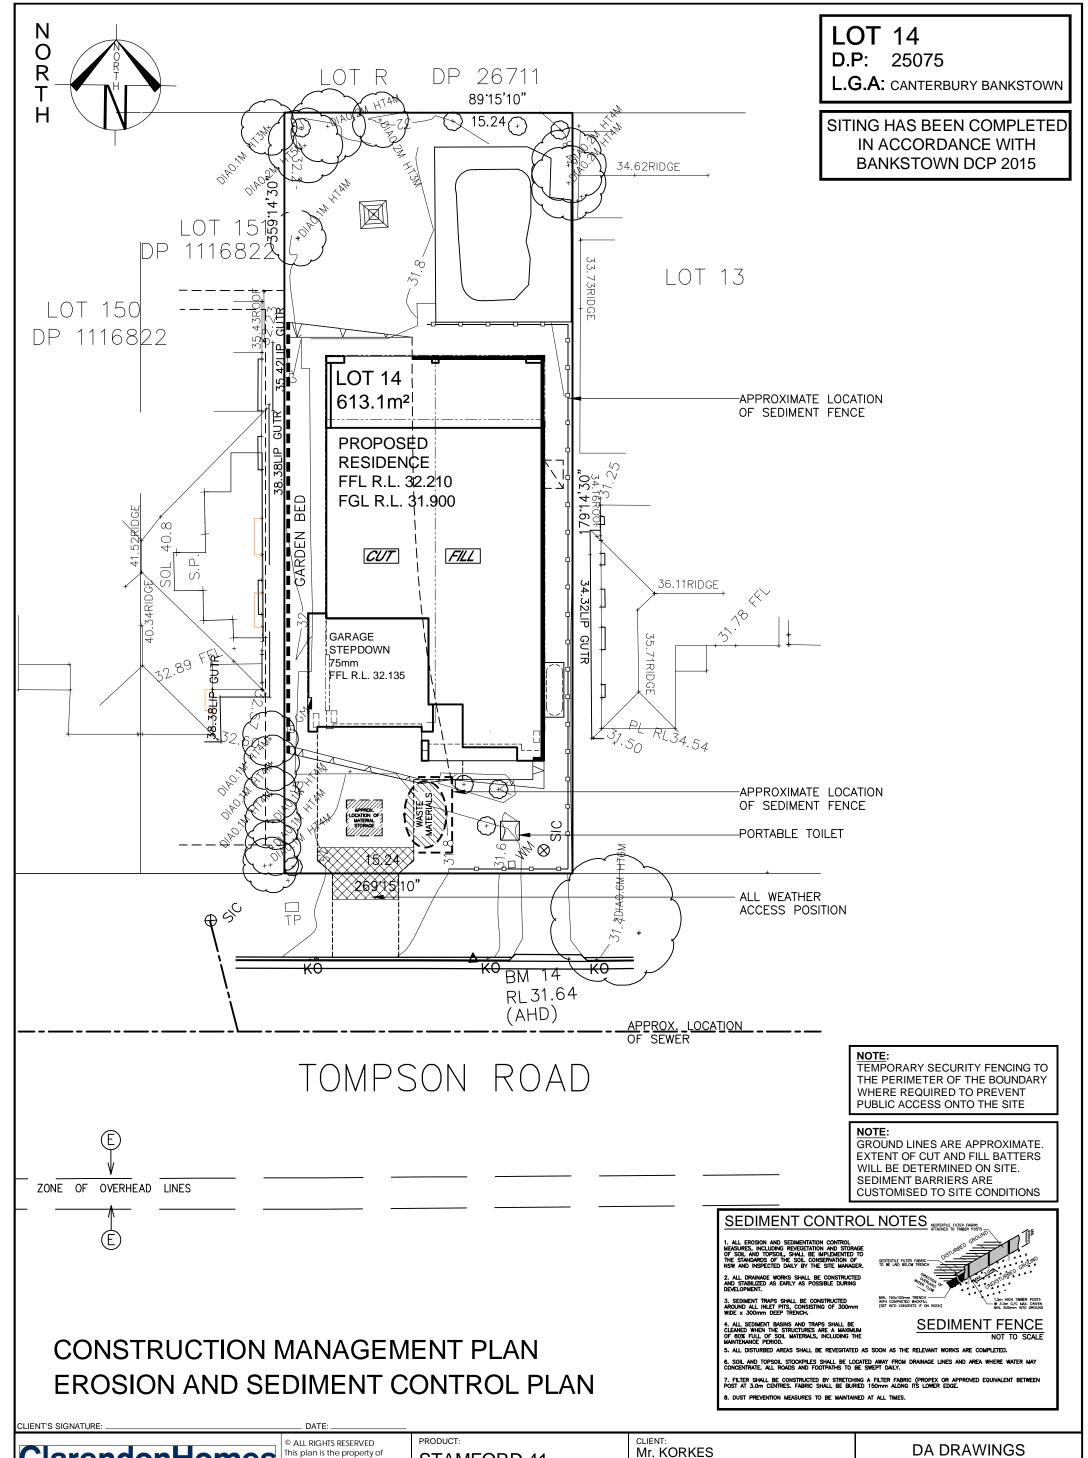
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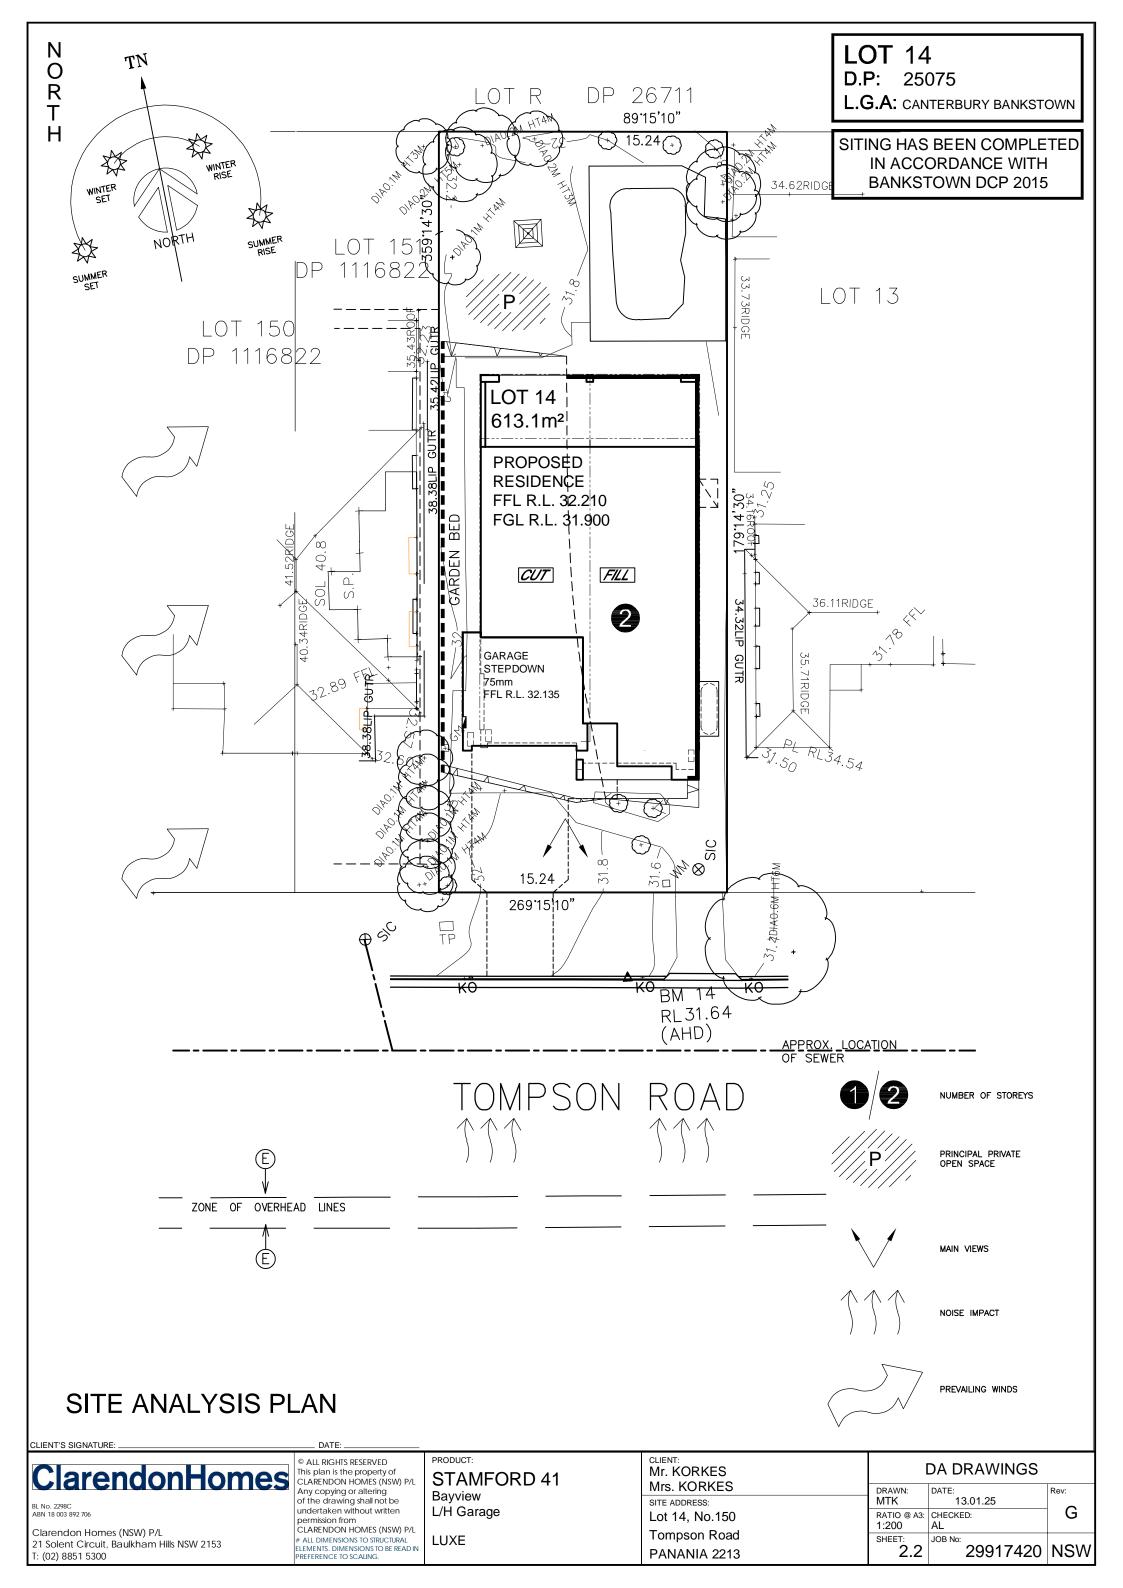
PRODUCT: STAMFORD 41 Bayview L/H Garage


LUXE


CLIENT: DA DRAWINGS Mr. KORKES Mrs. KORKES DRAWN: MTK DATE: Rev: SITE ADDRESS: 13.01.25 G RATIO @ A3: CHECKED: AL Lot 14, No.150 Tompson Road SHEET: JOB No: 29917420 NSW PANANIA 2213



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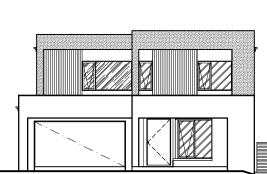


LOT 14 D.P: 25075

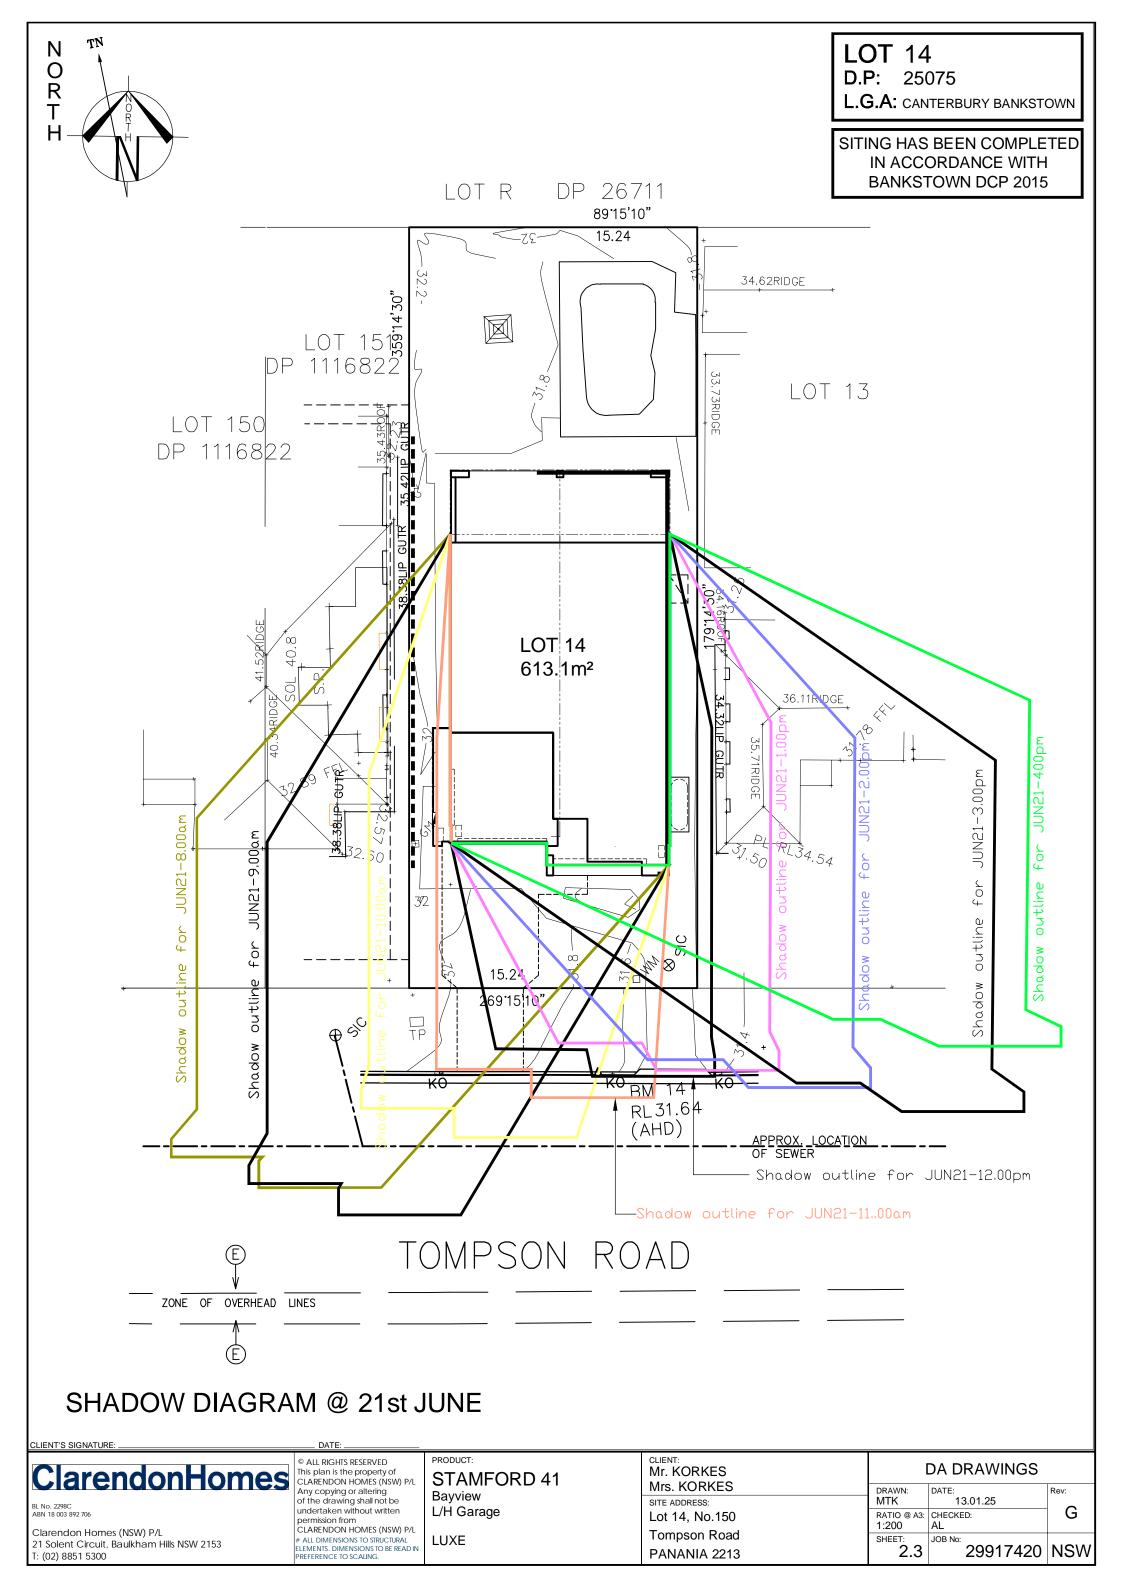L.G.A: CANTERBURY BANKSTOWN

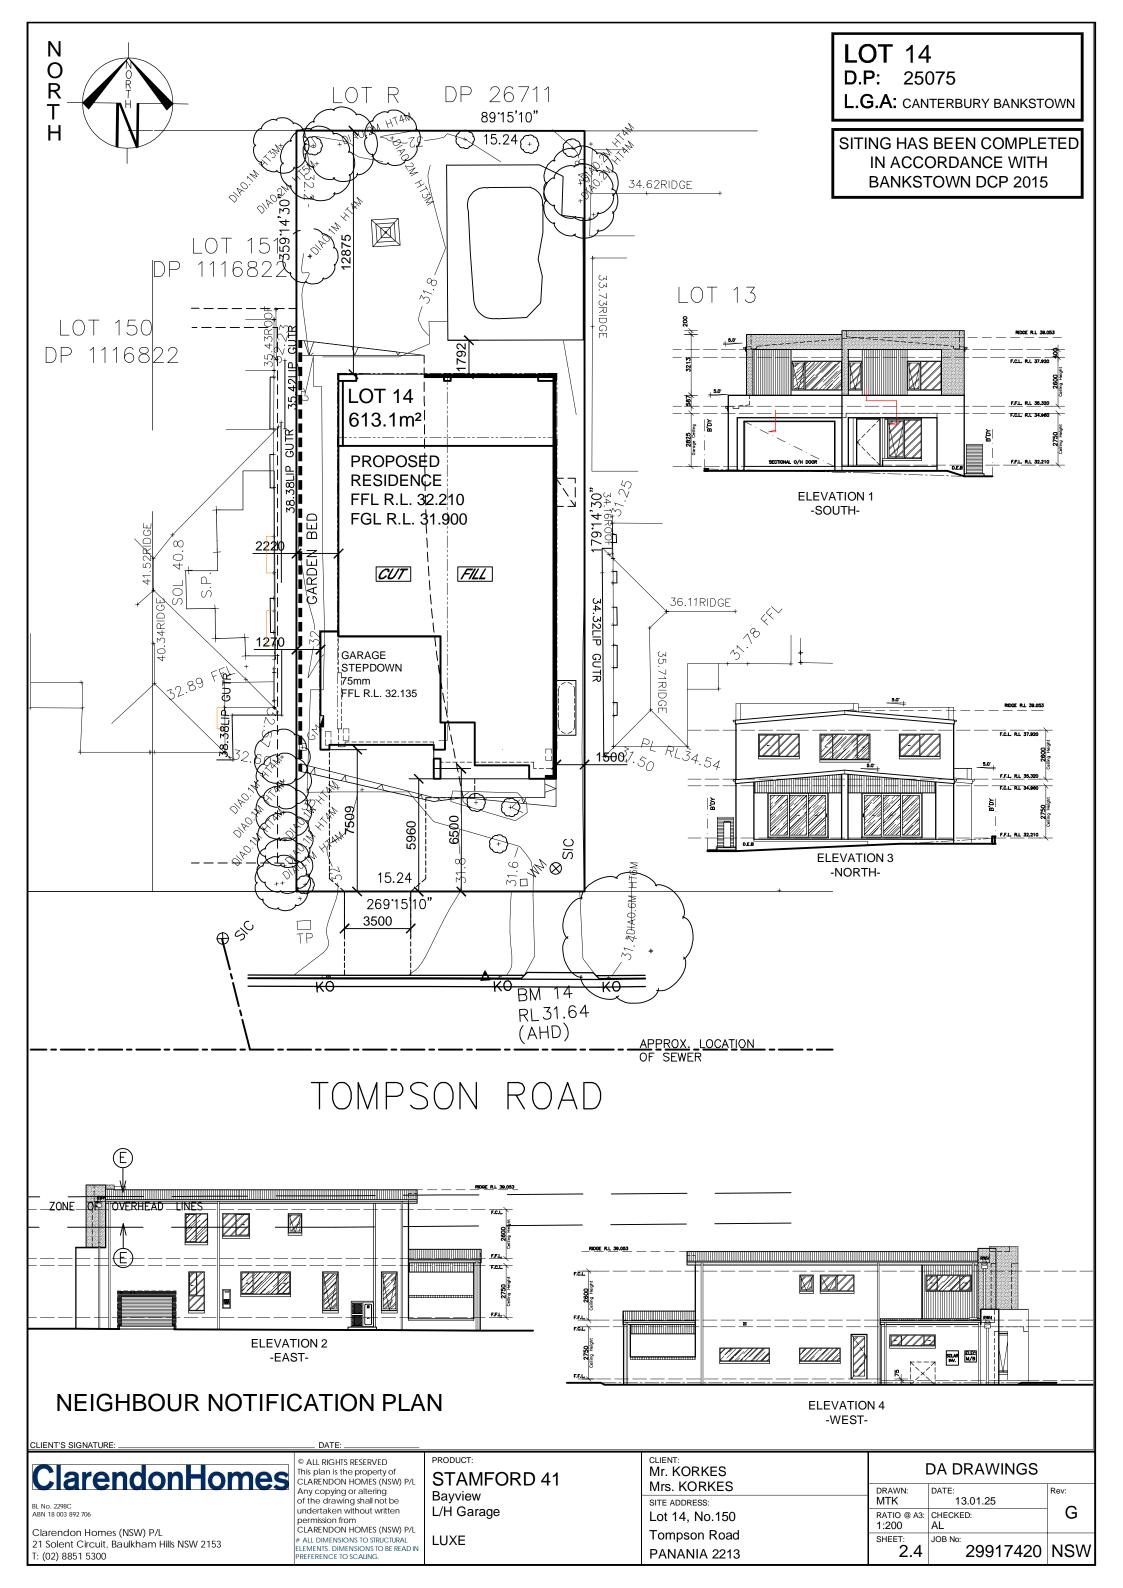SITING HAS BEEN COMPLETED IN ACCORDANCE WITH BANKSTOWN DCP 2015







No. 152A / No 152 No. 150 No. 148

# VIEW FROM TOMPSON ROAD

### STREETSCAPE ELEVATION

CLIENT'S SIGNATURE:

\_ DATE:

## ClarendonHomes

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PRODUCT: STAMFORD 41 Bayview L/H Garage

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